ABUTTERS LIST

Tax Map 121 Let 29 Luzi Panteno Rev. Trust of 2015 ofo Luzi Pantano 188 Hall Road Barrington, NH 03825

Tax Map 121 Lot5 Saily G. Milchal Rav. Living Trust c/o Saily G. Milchel 1424 Lewis Ridge View Colorado Springs, CO 80907

Tax Map 121 Lot 27 David White 216 Hall Road Barrington, NH 03825



GRAVEL = 224*88 S
PAVEMENT = 2780 SF
BUILINGS = 8350 SF
RV = 87500 SF
TOTAL = 322818 SF
TOTAL = 1.082,130 SF
PERCENT LOT COVERAGE = 29.8%

RECEIVED

OCT 13 2020

Site Plan FOR

BARRINGTON SHORES, LLC located at LAND USE OFFICE? BARRINGTON SHORES DRIVE Barrington, New Hampshire 03825 TAX MAP 121 LOT 28



TAX MAP

COVER SHEET

SHEET INDEX:

PERIMETER PLAN EXISTING CONDITIONS CAMPSITE LAYOUT C-3 C-4 P-1

P-2

D-1

D-2

LANDSCAPE PLAN

BY STONEWALL SURVEYING BY STONEWALL SURVEYING BY STONEWALL SURVEYING GRADING PLAN DRAINAGE PROFILE DRAINAGE PROFILE PLAN AND PROFILE PLAN AND PROFILE **DETAILS** BY STONEWALL SURVEYING PLANNING BOARD APPROVAL BLOCK

LEGEND

POORLY DRAINED SOILS 2' CONTOUR 10' CONTOUR STONEWALL UTILITY POLE EDGE OF GRAVE EDGE OF GRAVEL PROPOSED PROPOSED CONTOUR SILT FENCE/SILT SOXX



CONSTRUCTION TIME TABLE:

WAIVER REQUESTS:

TOWN OF BARRINGTON SITE PLAN REVIEW REGULATIONS:

1. ARTICLE 6. SECTION 6.2.3 (2) Placement. No site within the commercial recrections compground or comping park shall be located within one hundres feet (100 ft.) of any boundary line. All comparises must be screened from adjacent properties by a naturally vegetated buffer, or other screening approved by the Planning Board.

2. ARTICLE 4.7.7(1) - MINIMUM ALLOWABLE STORM DRAIN PIPE DIAMETER IS 15". WE ARE PROPOSING 12".

3. ARTICLE 4.12 - OUTDOOR LIGHTING. WE ARE PROPOSING NOT FIXED OUTDOOR LIGHTING.

LOCATION PLAN

1. TAX MAP 121 LOT 2B

2. SEE EXISTING CONDITIONS PLAN BY STONEWALL SURVEY

THE INTENT OF THIS PLAN IS FOR 27 NEW SEASONA... CAMPER SITES, NCLUDING ROAD LAYOUT DRAINAGE IMPROVEMENTS AND NEW SEPTIC SYSTEM AND WATER SYSTEM.

F, DURING CONSTRUCTION, IT BECOMES APPARENT THAT DEFICIENCIES EXIST IN THE APPROVED DESIGN DRAWNOS, THE OWNER SHALL BE REQUIRED TO CORRECT THE DEFICIENCIES TO MEET THE REQUIREMENTS OF THE REGULATIONS AT NO EXPENSE TO THE TOWN.

IF, DURING CONSTRUCTION, IT BECOMES APPARENT THAT ADDITIONAL EROSION CONTROL MEASURES ARE REQUIRED TO STOP ANY EROSION ON THE CONSTRUCTION SITE DUE TO ACTUAL SITE CONDITIONS, THE OWNER SHALL BE REQUIRED TO INSTALL THE NECESSARY EROSION PROTECTION AT NO EXPENSE TO THE TOWN.

7. ALL MATERIALS AND METHODS OF CONSTRUCTION SHALL CONFORM TO THE TOWN OF BARRINGTON SITE REVEW REQULATIONS AND THE LATEST EDITION OF THE NEW HAMPSHIRE DEPARTMENT OF TRANSPORTATIONS STANDARD SPECFICATIONS FOR ROAD AND BRIGE CONSTRUCTION. B. IN ACCORDANCE WITH TOWN REGULATIONS AND RSA 676:13, ALL IMPROVEMENTS SPECIFED ON THESE SITE PLANS SHALL BE CONSTRUCTED, COMPLETED, INSPECTED AND APPROVED BY THE TOWN OF BARRINGTON PRIOR TO THE ISSUANCE OF A CERTIFICATE OF OCCUPANCY.

WATER AND SEWER LINE LOCATIONS ARE APPROXIMATE FIELD ADJUSTMENTS MAY BE NECESSARY.

10. CRADING WITHIN 250 FEET OF THE LAKE REQUIRES A SHORELAND PERMIT.





ENGINEERING


SERVICES, LLC

APPROVAL

ISSUE DATE:

MARCH 6, 2020 FILE NAME:

1958-BARRINGTON SHORES

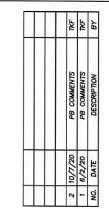

VARIES


BARRINTON SHORES, LLC 240 REVERE STREET WINTHROP, MA 02152


TAX MAP/LOT 121/28 7 BARRINGTON SHORE DRIVE BARRINGTON, NH

COVERSHEET

SHEET NUMBER:



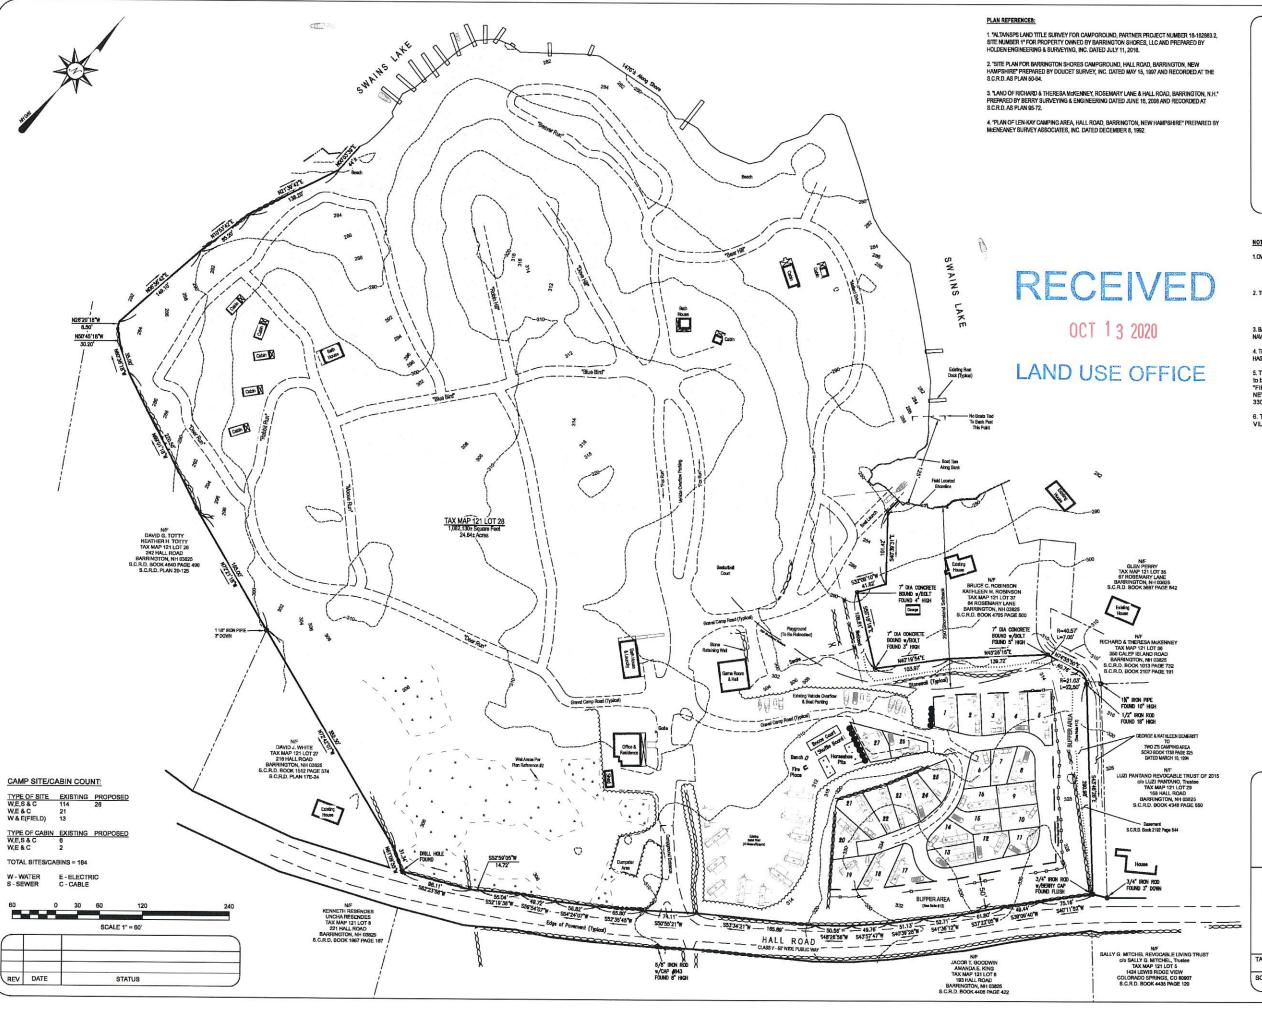

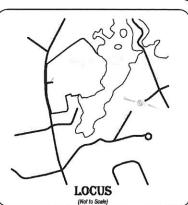

BARRINGTON SHORES, LLC S.C.R.D. BOOK 3890 PAGE 938

2. TOTAL PARCEL AREA: 1,082,130± Square Feet 24.84± Acres (Area per Plan Reference

3. BASIS OF BEARING IS PER NH GRID AND THE VERTICAL DATUM IS BASED UPON NAVD 1988 OBTAINED BY GPS ON OCTOBER 15, 2019.

4. THE PERIMETER BOUNDARY OF THIS PARCEL IS PER PLAN REFERENCE #1 AND HAS NOT BEEN VERIFIED BY THIS FIRM.

5. THE SUBJECT PARCEL IS IN FLOOD ZONE "X" (Areas Determined to be Outside the 0.2% Annual Chance Floodplain) AS SHOWN ON THE "FIRM, FLOOD INSURANCE RATE MAP, STRAFFORD COUNTY, NEW HAMPSHIRE, PANEL 256 OF 405, MAP NUMBER 33017CO295D" WITH AN EFFECTIVE DATE OF MAY 17, 2005.

6. THE SUBJECT PARCEL IS SERVICED BY THE SWAIN'S LAKE VILLAGE WATER DISTRICT.



PERIMETER SURVEY PLAN


of Property Located at: 7 Barrington Shores Drive Barrington, NH 03825


For: Barrington Shores, LLC 240 Revere Street Winthrop, MA 02152




Licensed in New Hampshire & Maine PO Box 458, Barrington, NH 03825 t: (603) 664-3900 www.StonewallSurveying.com

TAX MAP & LOT NO: 121 / 28		DRAWING NO: 18036 Layout 2020.dwg			
SCALE:	SHEET:	PROJECT NO:	DATE:	,	
1" = 60'	1 of 3	18036	3/6/2020		

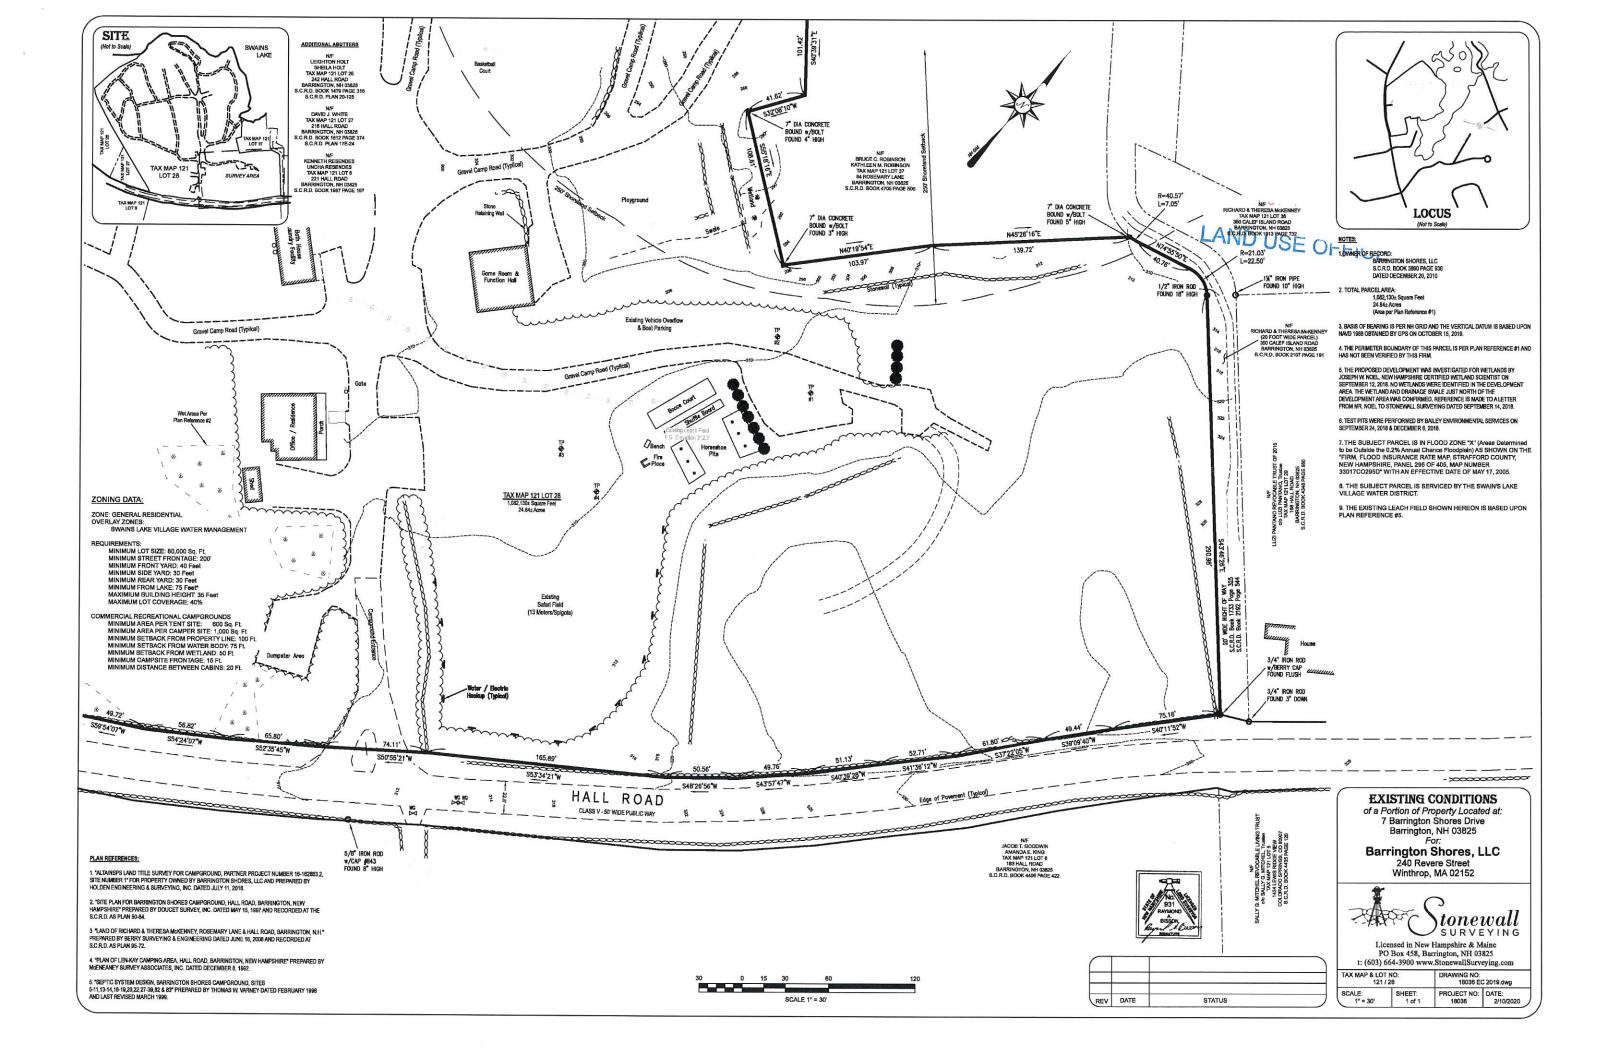

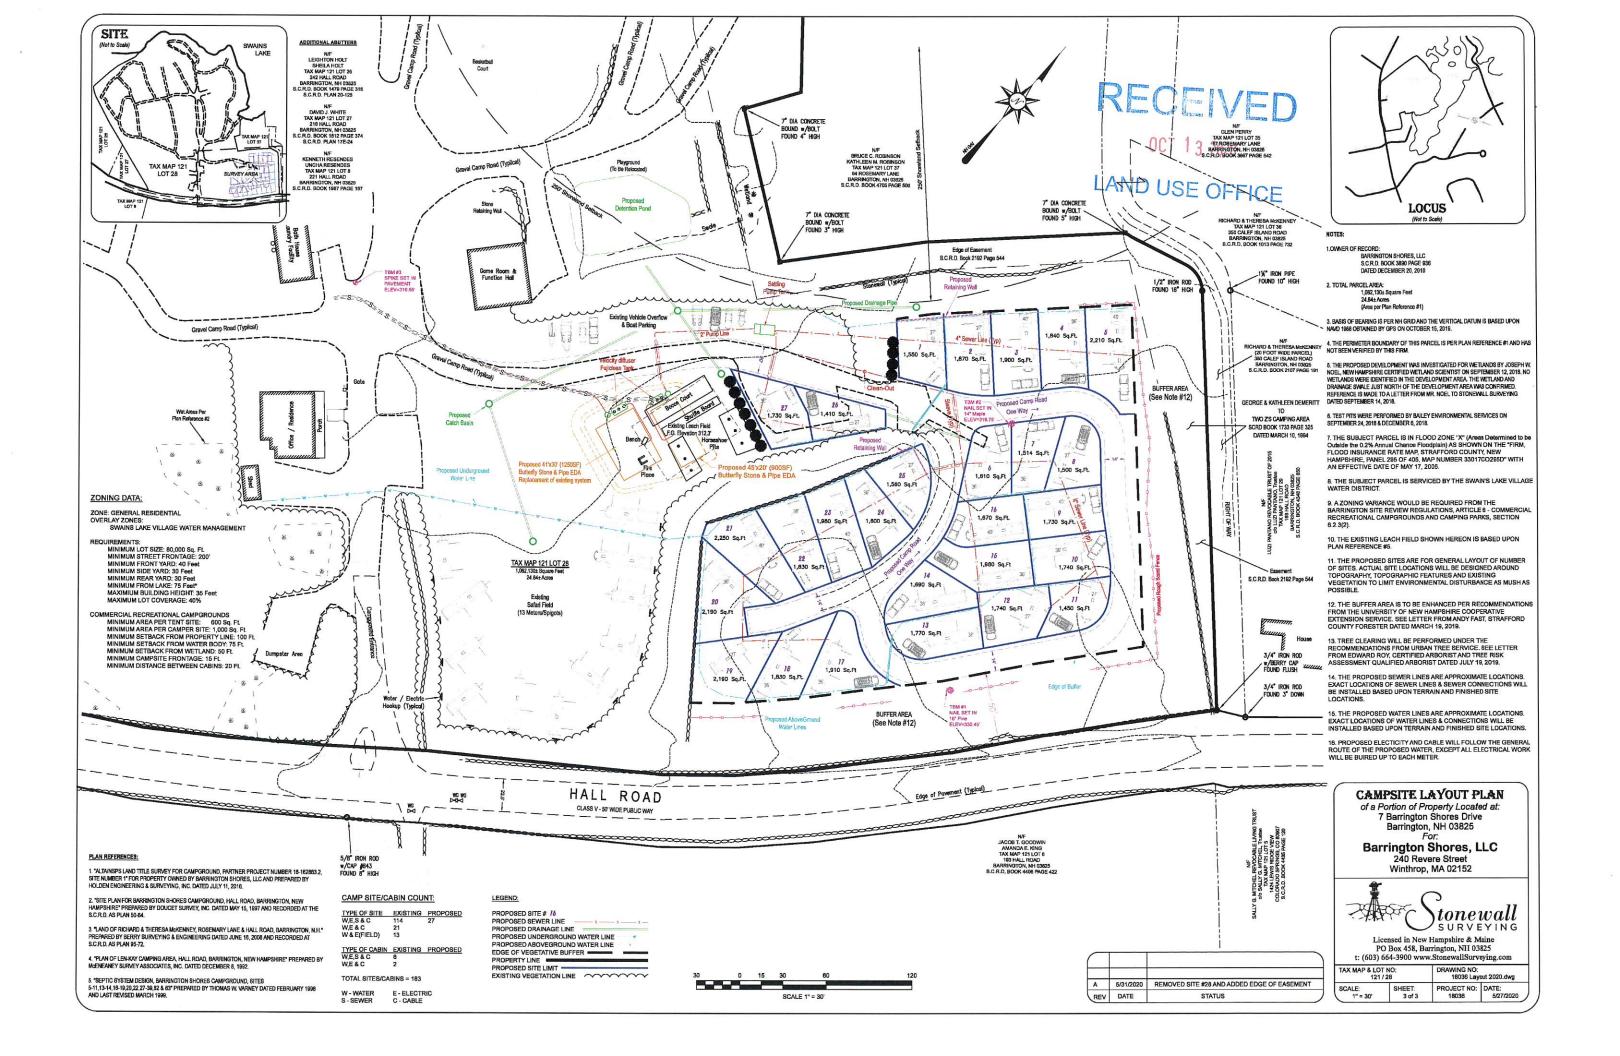

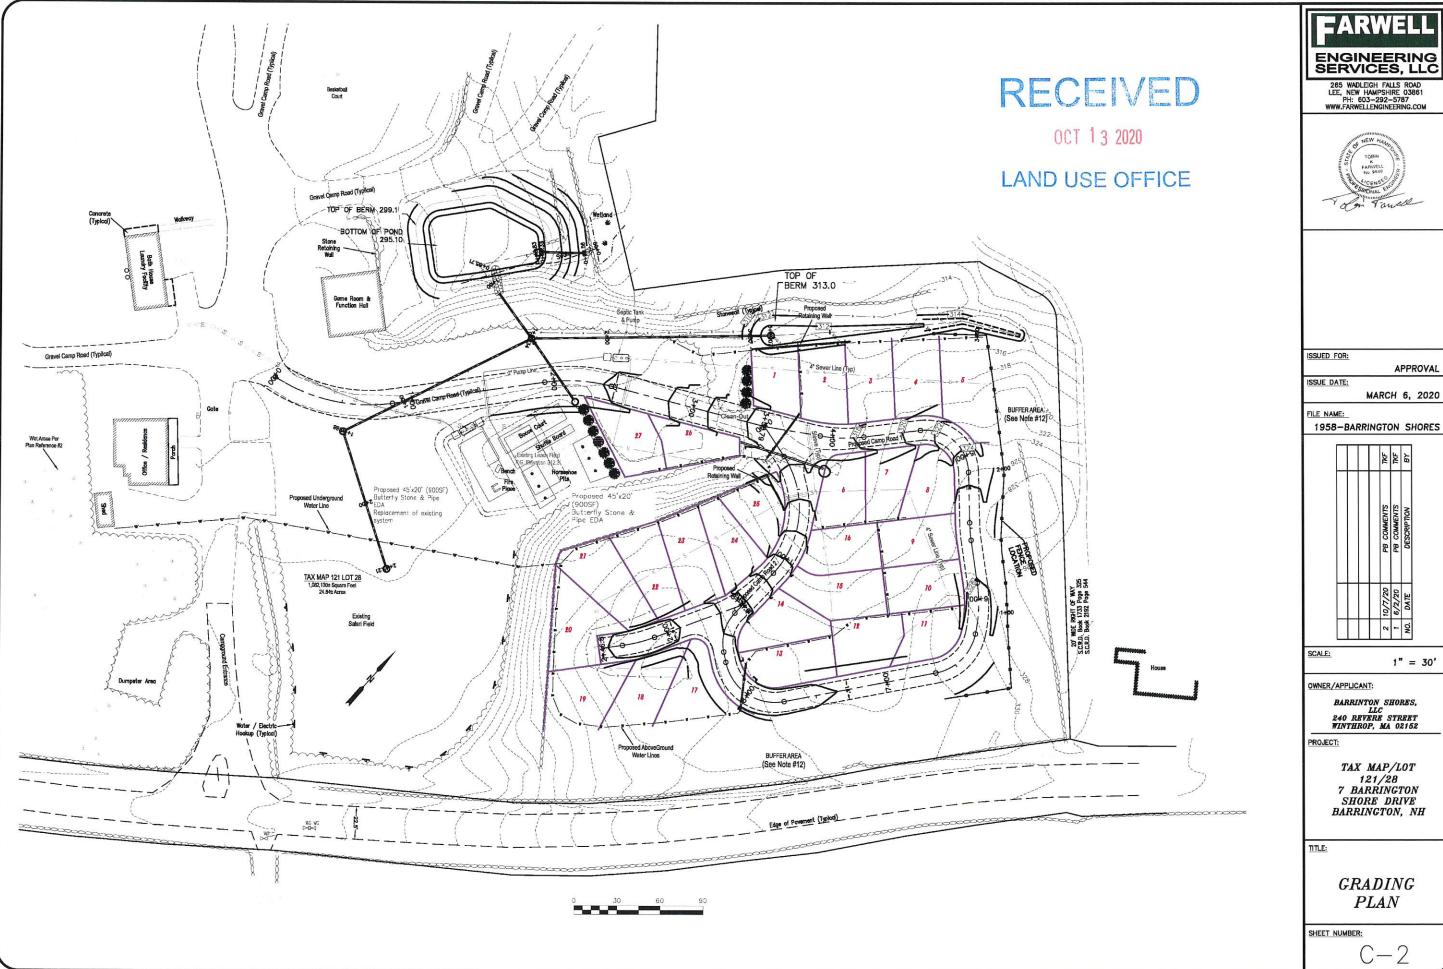


ENGINEERING SERVICES, LLC



APPROVAL


MARCH 6, 2020

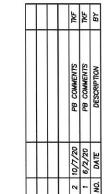


1" = 30'

TAX MAP/LOT 121/28
7 BARRINGTON
SHORE DRIVE
BARRINGTON, NH

GRADING

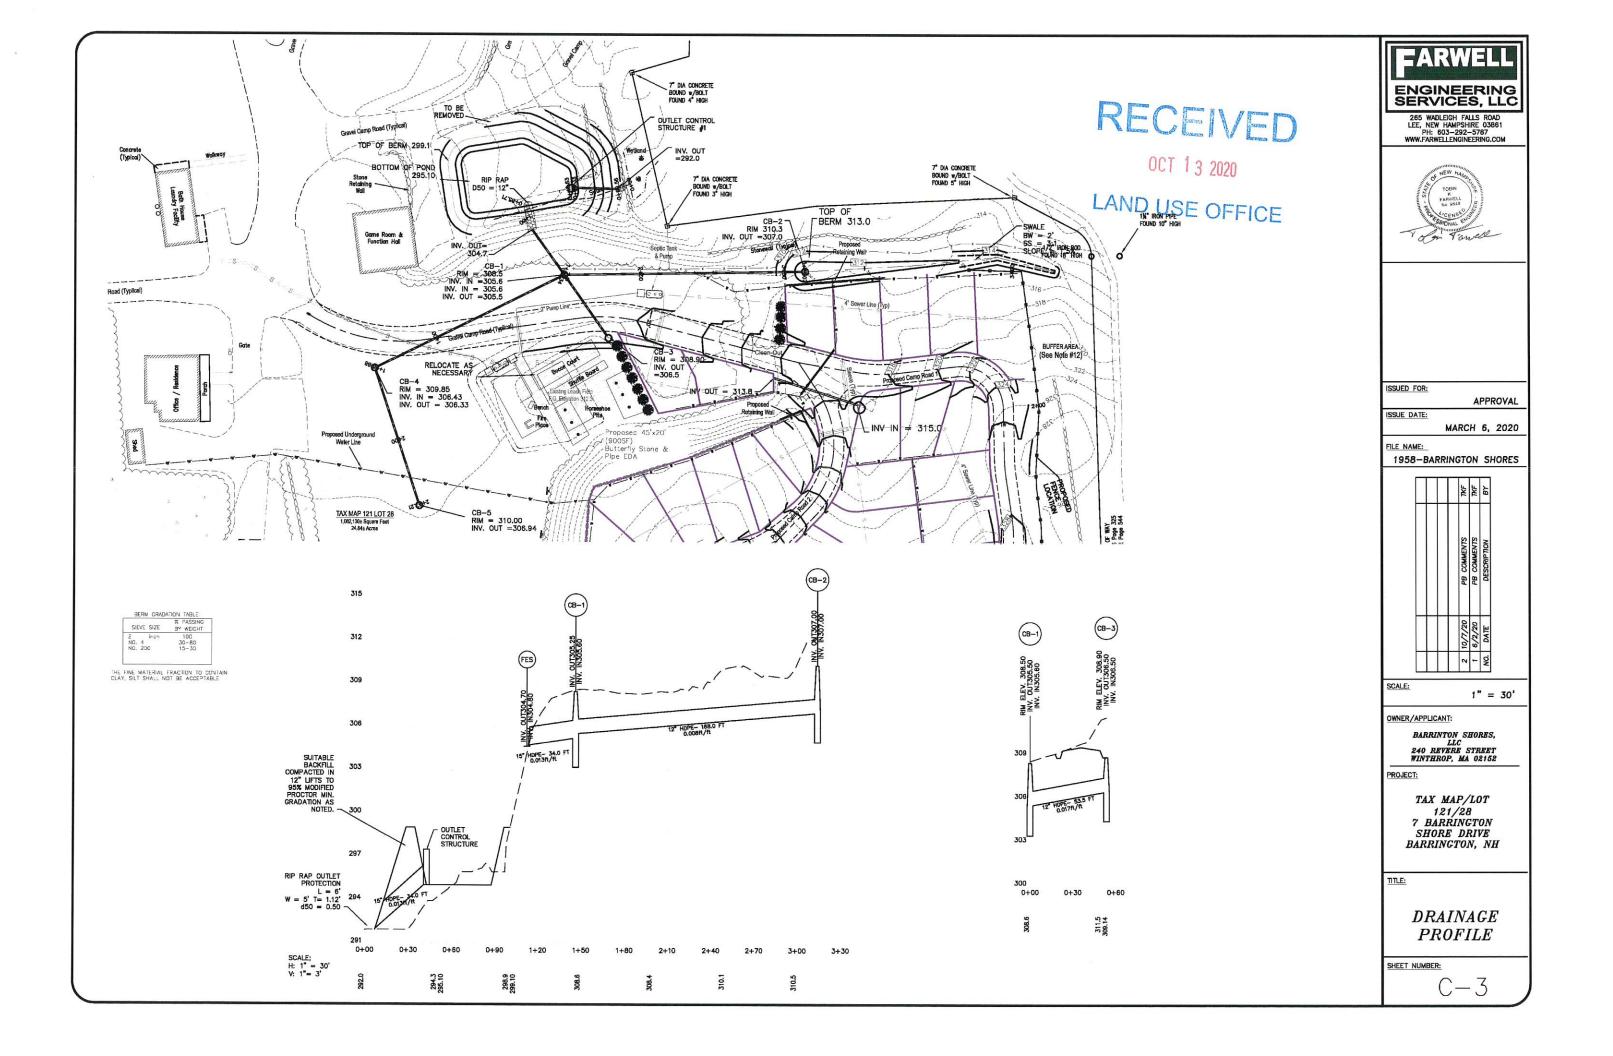

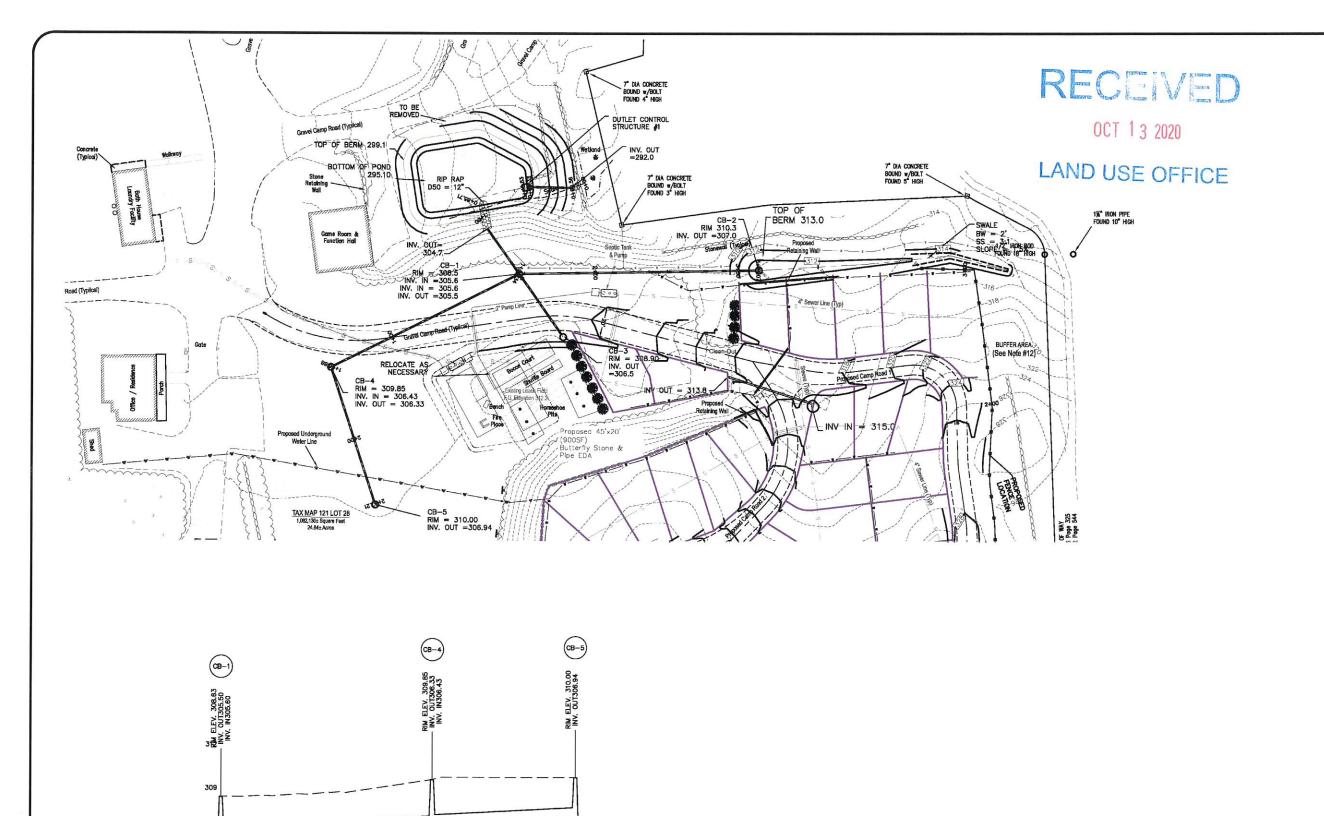

2+40



265 WADLEIGH FALLS ROAD LEE, NEW HAMPSHIRE 03861 PH: 603-292-5787 WWW.FARWELLENGINEERING.COM



ISSUED FOR:


APPROVAL

ISSUE DATE:

MARCH 6, 2020

FILE NAME:

1958-BARRINGTON SHORES

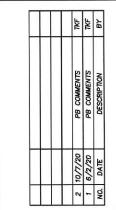

SCALE:

1" = 30"

OWNER/APPLICANT:

BARRINTON SHORES, LLC 240 REVERE STREET WINTHROP, MA 02152

PROJECT


TAX MAP/LOT 121/28 7 BARRINGTON SHORE DRIVE BARRINGTON, NH

TITLE:


DRAINAGE PROFILE

SHEET NUMBER:

C - 4

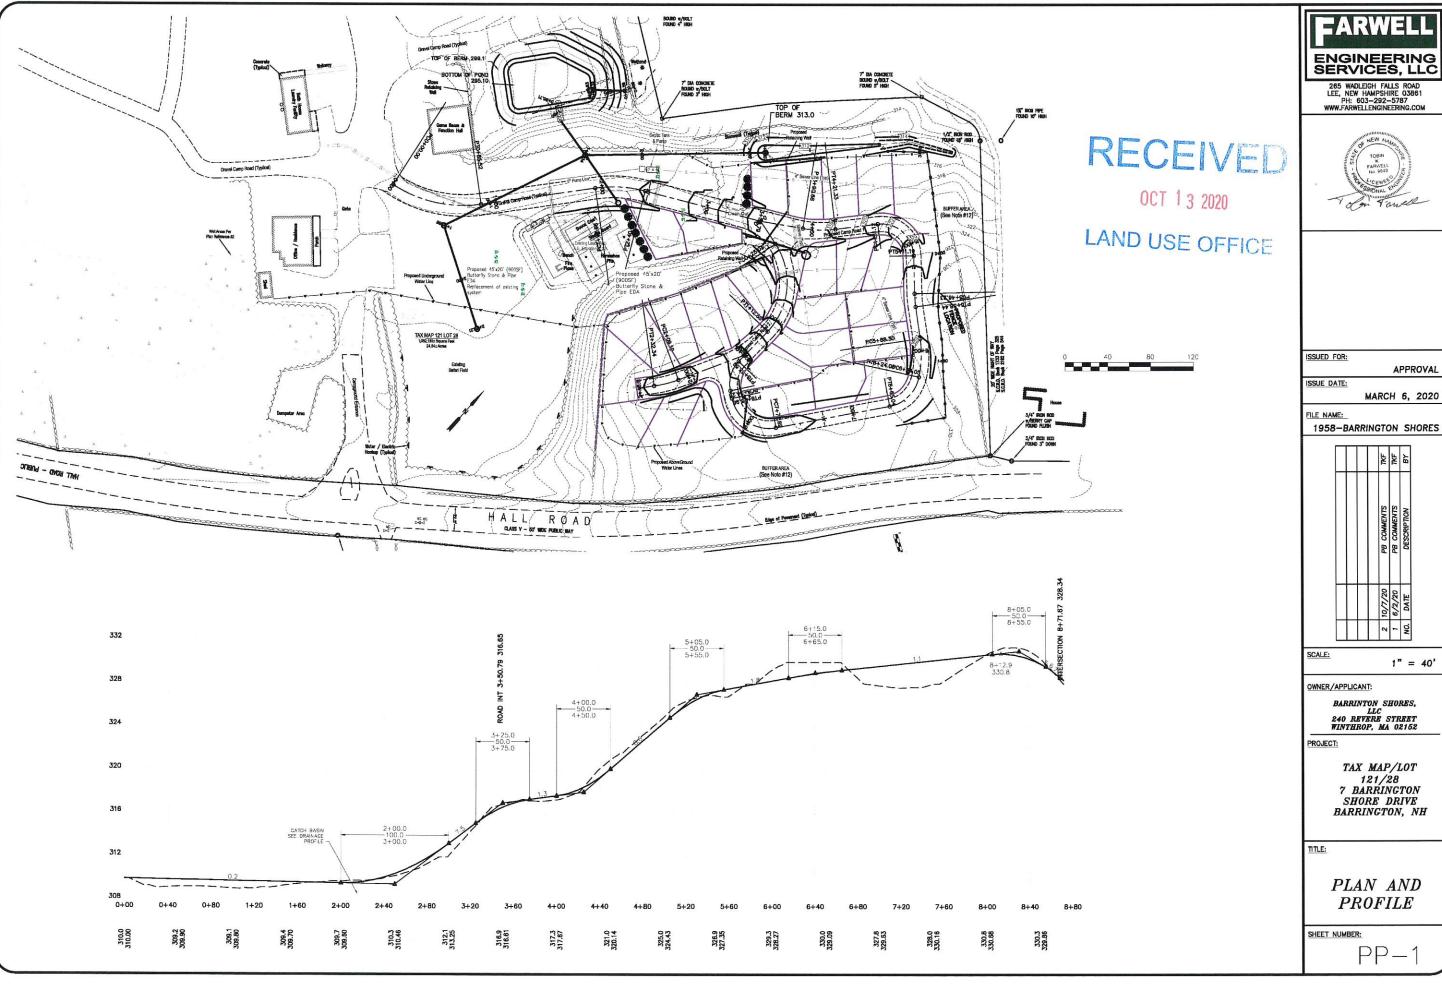

ENGINEERING SERVICES, LLC

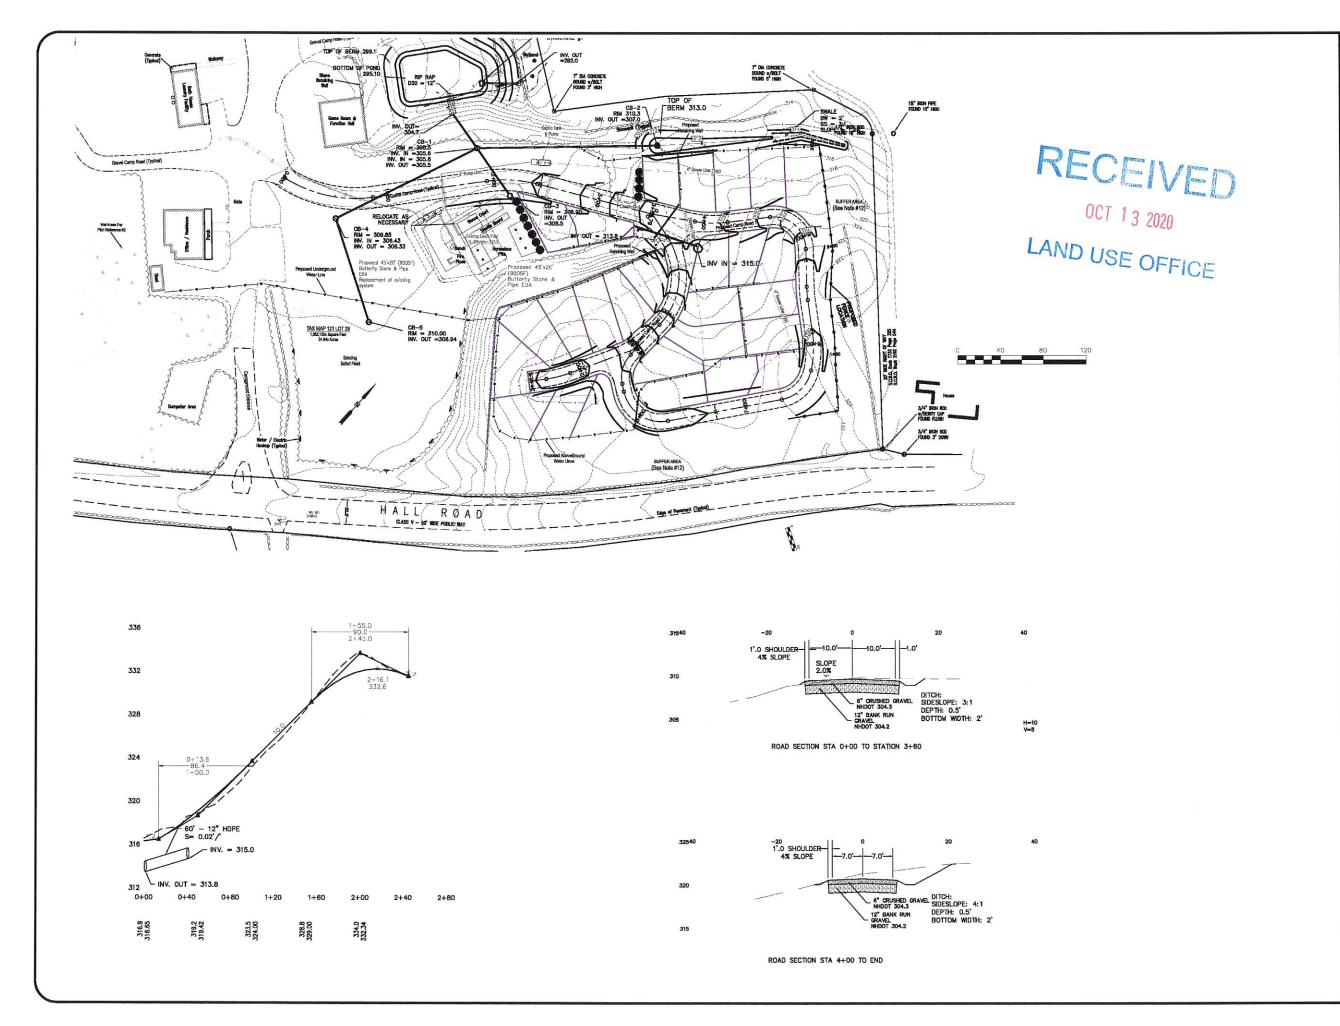

FARWEL ENGINEERING SERVICES, LLC

265 WADLEIGH FALLS ROAD LEE, NEW HAMPSHIRE 03861 PH: 603-292-5787 WWW.FARWELLENGINEERING.COM



ISSUED FOR:


APPROVAL

MARCH 6, 2020

ISSUE DATE:

FILE NAME:

1958-BARRINGTON SHORES

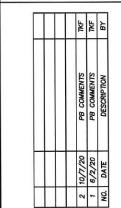

SCALE:

1" = 40'

OWNER/APPLICANT:

BARRINTON SHORES, LLC 240 REVERE STREET WINTHROP, MA 02152

TAX MAP/LOT 121/28 7 BARRINGTON SHORE DRIVE BARRINGTON, NH

TITLE:

PLAN AND **PROFILE**

SHEET NUMBER:

PP-2

PROJECT NAME AND LOCATION

BARRINGTON SHORES
7 BARRINGTON SHORE DRIVE

LATITUDE: 043' 11' 06" N LONGITUDE: 071' 1' 37" W

DESCRIPTION

EXPANSION OF SEASONAL RENTAL AREAS - DRAINAGE IMPROVEMENTS - NEW SEPTIC SYSTEM & WATER SYSTEM EXPANSION.

DISTURBED AREA

THE TOTAL AREA TO BE DISTURBED IS APPROXIMATELY 83,000 sf± (1.9 AC.±)

SEQUENCE OF MAJOR ACTIVITIES

- PERIMETER CONTROLS SHALL BE INSTALLED PRIOR TO EARTH MOVING OPERATIONS
 CRUB SITE AND HAUL STUMPS OFF SITE.
 ALL DITCHES AND SWARES SHALL BE STABLIZED PRIOR TO DIRECTING RUNDEF TO THEM.
 ALL ROADWAY SHALL BE STABLIZED WITH 72 HRS OF ACHIEVENC FINISHED GRADE.
 ALL CUT AND FILL SLOPES SHALL BE SECEDE/LOAMED WITHIN 72 HRS OF ACHIEVING FINISHED CRADE.
 ALL EROSION CONTROLS SHALL BE INSPECTED WEEKLY AND AFTER EVERY 1/2" OF RANHALL.

NAME OF RECEIVING WATERS

TEMPORARY EROSION AND SEDIMENT CONTROLS AND STABILIZATION PRACTICES

AS INDICATED IN THE SEQUENCE OF MAJOR ACTIVITIES THE SILT FENCES/SILT SOCK SHALL BE INSTALLED PRIOR TO COMMENCING ANY CLEARING OR GRADING OF THE SITE. STRUCTURAL CONTROLS SHALL BE INSTALLED CONCURRENTIL WITH THE APPLICABLE CACTIVITY. AREAS WHERE CONSTRUCTION ACTIVITY TEXPORARILY CEASES FOR MORE THAN TWENTY EIGHT (28) DAYS WILL BE STABILIZED WITH A TEMPORARY SEED AND MULCH WITHIN TWENTY—ONE (21) DAYS OF THE LAST DISTURBANCE. ONCE CONSTRUCTION ACTIVITY IS COMPLETED IN AN AREA, SILT FENCES/SILT SOCK, BARRIERS AND ANY EARTH/DIKES WILL BE REMOVED ONCE PERMANENI MEASURES ARE ESTABLISHED.

DURING CONSTRUCTION, RUNOFF WILL BE DIVERTED AROUND THE SITE WITH STABILIZED CHANNELS WHERE POSSIBLE. SHEET RUNOFF FROM THE SITE WILL BE FILTERED THROUGH SILT FENCES/SIL SOCK.

INSTALLATION. MAINTENANCE AND INSPECTION PROCEDURES FOR TEMPORARY EROSION AND SEDIMENT CONTROL MEASURES

THESE ARE THE GENERAL INSPECTION AND MAINTENANCE PRACTICES THAT WILL BE USED TO IMPLEMENT THE PLAN

- 1. THE SMALLEST PRACTICAL PORTION OF THE SITE WILL BE DENUDED AT ONE TIME.
- ALL CONTROL MEASURES WILL BE INSPECTED AT LEAST DIGG EACH WEEK AND FOLLOWING ANY STORM EVENT OF 0.5 INCHES OR GREATER.
- 3. ALL MEASURES WILL BE MAINTAINED IN GOOD WORKING ORDER; IF A REPAIR IS NECESSARY IT WILL BE INITIATED WITHIN 24 HOURS.
- BUILT UP SEDIMENT WILL BE REMOVED FROM SILT FENCE OR HAY BALE BARRIERS WHEN IT
 HAS REACHED ONE THIRD THE HEIGHT OF THE FENCE OR BALE, OR WHEN "BUILGES" OCCUR.
- 5. ALL DIVERSION DIKES WILL BE INSPECTED AND ANY BREACHES PROMPTLY REPAIRED.
- TEMPORARY SEEDING AND PLANTING WILL BE INSPECTED FOR BARE SPOTS, WASHOLTS, AND UNHEALTHY GROWTH.
- 7. A MAINTENANCE INSPECTION REPORT WILL BE MADE AFTER EACH INSPECTION.
- THE CONTRACTOR'S SITE SUPERINTENDENT WILL BE RESPONSIBLE FOR INSPECTIONS, MAINTENANCE AND REPAIR ACTIVITIES, AND FILLING DUT THE INSPECTION AND MAINTENANCE REPORT.
- THE OWNER'S AUTHORIZED ENGINEER SHALL INSPECT THE SITE ON A PERIODIC BASIS TO ASSURE COMPLIANCE WITH THE PLANS.

B. MULCHING

- A. APPLY MULCH PRIOR TO ANY STORM EVENT, THIS IS APPLICABLE WHEN WORKING WITHIN 100 FEET OF WETLANDS. IT WILL BE NECESSARY TO CLOSELY MONTOR WEATHER PREDICTIONS, USUALLY BY CONTACTING THE NATIONAL WEATHER SERVICE IN CONCORD, TO HAVE ADEQUATE WARRING OF SIGNIFICANT STORMS.
- B. REQUIRED MULCHING WITHIN A SPECIFIED TIME PERIOD, THE TIME PERIOD CAN RANGE FROM 21 TO 28 DAYS OF INACTIVITY ON A AREA, THE LENGTH OF TIME VARTING ACCORDING TO SITE CONDITIONS. PROFESSIONAL JUDGINENT SHALL BE USED TO EMULANTE THE INTERFACTION OF SITE CONDITIONS (SOIL ERODIBLITY, SEASON OF YEAR, EXTENT OF DISTURBANCE, PROXIMITY TO SENSITIVE RESOURCES, ETC.) AND THE POTENTIAL IMPACT OF EROSION ON ADJACENT AREAS TO CHOOSE AN APPROPRIATE THE RESTRICTION.
- 2. GUIDELINES FOR WINTER STABILIZATION
- A. ALL PROPOSED POST-DEVELOPMENT VEGETATED AREAS WHICH DO NOT EXHIBIT A MINIMUM OF 85% VEGETATIVE GROWTH BY OCTOBER 15TH OR WHICH ARE DISTURBED AFTER OCTOBER 15TH SHALL BE STABILIZED BY SEEDING AND INSTALLINE FROSON CONTROL BLANKETS ON SUPES GREATER 14M 31, AND SEEDING AND PLACING 3 TO 4 TONS OF MULCH PER ACRE, SECURED WITH ANCHOR NETTING, AND SEEDING AND PLACING 3 TO 4 TONS OF MULCH PER ACRE, SECURED WITH ANCHOR NETTING SEEDING AND PLACING SHALL NOT OF OVER ACCUMULATED SNOW OR ON FROZEN GROUND AND SHALL BE COMPLETED IN ADVANCE OF THAW SPRVG MELT EVENTS.

B. ALL DITCHES OR SWALES WHICH DO NOT EXHIBIT A MINIMUM OF 85% VEGETATIVE GROWTH BY OCTOBER 15TH OR WHICH ARE DISTURBED AFTER OCTOBER 15TH SHALL BE STABILZED WITH STONE OR EROSINO CONTROL BLANKETS APPROFARE FOR THE DESIGN FLOW CONDITIONS.

C. AFTER NOVEMBER 15TH, INCOMPLETE ROAD OR PARKING SURFACES SHALL BE PROTECTED WITH A MINIMUM OF 3-MCHES OF CRUSHED SRAWE, PER NHODT TIEV 30A.3 OR IF CONSTRUCTION IS TO CONTRIBUTED AS THE ACM STORM FOR CLEARED OF ANY ACCUUMLATED SNAW AFTER EACH STORM EVENT.

A. SILT FENCE BARRIERS SHALL BE INSPECTED IMMEDIATELY AFTER
EACH RAINFALL AND AT LEAST DAILY DURING PROLONGED RAINFALL. THEY SHALL BE REPAIRED
IF 1-EER ARE ANY SIONS OF EROSON OR SEDUMENTATION BELOW THEM. ANY REQUIRED REPAIRS
SHALL BE MADE IMMEDIATELY. IF THERE ARE SIONS OF UNDERCUTTING AT THE CENTER OR THE
REPLICED WITH A TEMPOLAPING OF LARGE VOLUMES OF WATER, THE SEDIMENT BARRIERS SHALL BE
REPLICED WITH A TEMPORARY CHECK DAM.

B. SHOULD THE FABRIC ON A SILT FENCE FILTER BARRIER DECOMPOSE OR BECOME INEFFECTI REDGR. TO THE END OF THE EXPECTED JSABLE LIFE AND THE BARRIER IS STILL NECESSARY THE FABRIC SHALL BE REPLACED PROMPTLY.

- C. SEDIVENT DEPOSITS MUST BE REMOVED WHEN DEPOSITS REACH APPROXIMATELY ONE THIRD (1/3) THE HEIGHT OF THE BARRIER.
- OCT 13 2020 C. SELIVEN DE SARIÈR.

 THE HEIGHT OF THE BARRIÈR.

 ANY SEDIMENT DEPOSITS REMAINING IN PLACE AFTER THE SILT FENCE OR HAY BALE BARRIER IS NO LONGER REQUIRED SHALL BE REMOVED. THE AREA SHALL BE PREPARED AND SELDED.
 - E. ADDITIONAL STONE WAY HAVE TO BE ADDED TO THE CONSTRUCTION ENTRANCE, ROCK BARRIER STONE LINED SWALES, ETC., PERIODICALLY TO MAINTAIN PROPER FUNCTION OF THE EROSION

- SEEDBED PREPARATION
 APPLY FERTILIZER AT THE RATE OF 600 POUNDS PER ACRE OF 10-10-10.
 APPLY UNSTIONE (EQUIVALENT TO 50 PERCENT CALCIUM PLUS
 MAGNESIUM OXIDE) AT A RATE OF THREE (3) TONS PER ACRE.

- EDING

 UTILIZE ANNUAL RYE GRASS AT A RATE OF 40 LBS/ACRE.

 WHERE THE SOIL HAS BEEN COMPACTED BY CONSTRUCTION OPERATIONS, LODSEN
 SOIL TO A DEPTH OF TWO (2) INCHES BEFORE APPLYING FERTILIZER, LIME AND
 SEED.

 APPLY SEED UNIFORMLY BY HAND, CYCLONE SEEDER, OR HYDROSEEDER (SLURRY
 INCLUDING SEED AND FERTILIZER). HYDROSEEDINGS, WHICH
 INCLUDE MULCH, MAY BE LEFT ON SOIL SURFACE.
 SEEDING BRIES WUST BE INCREASED 10% WHEN HYDROSEEDING.
- MAINTENANCE
 TEMPORARY SEEDINGS SHALL BE PERIODICALLY INSPECTED. AT A MINIMUM, 95% OF
 THE SOIL SURFACE SHOULD BE COVERED BY VEGETATION. IF ANY EVIDENCE
 OF FROSION OR SEDIMENTATION IS APPARENT, REPARS SHALL BE VADE AND
 OTHER TEMPORARY MEASURES USED IN THE INTERIM (VULCH, FILTER
 BARRERS, CHECK DAMS, ETC.).

D. FILTERS

SILT FENCE
 A. SYNTHETIC FILTER FABRIC SHALL BE A PERVIOUS SHEET OF PROPYLENE, NYLON,
 POLYESTER OR ETHYLENE YARN AND SHALL BE CERTIFIED BY THE MANUFACTURER OR
 SUPPLER AS CONFORMING TO THE FOLLOWING REQUIREMENTS:

	SILT FENCE PROPERTIES	
PHYSICAL PROPERTY	TEST	REQUIREMENTS
GRABE TENSILE	ASTM-D-4632	95/80 LB
PUNCTURE	ASTM-D-4833	45 LB
FLOW RATE	ASTM-D-4491	5 GAL/MIN/SF
UV RESISTANCE	ASTM D-4751	80%
GRAB ELONGATION	ASTM D-4632	20/25%

Requirements reduced by 50 percent ofter six (6) months of installation.

SYNTHETIC FILTER FABRIC SHALL CONTAIN ULTRAVIOLET RAY INHIBITORS AND STABILIZERS TO PROVIDE A MINIMUM OF SIX (E) MONTHS OF EXPECTED USABLIC CONSTRUCTION LIFE AT A TEMPERATURE RANGE OF D DEGREES F TO 120° F.

- POSIS SHALL BE SPACED A MAXIMUM OF TEN (10) FEET APART AT THE BARRIER LOCATION OR AS RECOMMENDED BY THE WANLFACTURER AND DRIVEN SECURELY INTO THE GROUND (MINIMUM OF 16 INCHES).
- A TRENCH SHALL BE EXCAVATED APPROXIMATELY SIX (6) INCHES WIDE AND SIX (6) INCHES DEEP ALONG THE LINE OF POSTS AND UPSLOPE FROM THE BARRIER
- WHEN STANDARD STRENGTH FILTER FABRIC IS USED, A WIRE MESH SUPPORT FENCE SHALL BE FASTINED SECURELY TO THE UPSLOPE SIDE OF THE POSTS USING HEAVY DUTY WIRE STAPLES AT LEAST ONE (1) INCH LONG, TIE WIRES OR HOG RINGS, THE WIRE SHALL EXTEND NO MORE THAN 36 INCHES ABOVE THE ORIGINAL
- THE "STANDARD STRENGTH" FILTER FABRIC SHALL BE STAPLED OR WIRED TO THE FENCE, AND SIX (6) INCHES OF THE FABRIC SHALL BE EXTENDED INTO THE TRENCT. THE FABRIC SHALL NOT EXTEND MORE THAN 36 NOHES ABOVE THE ORIGINAL OROUND SURFACE. FILTER FABRIC SHALL NOT BE STAPLED TO EXISTING TREES.
- WHEN EXTRA STRENGTH FILTER FABRIC AND CLOSER POST SPACING ARE USED, THE WIRE VESH SUPPORT FENCE MAY BE ELIMINATED. IN SUCH A CASE, THE FILTER FABRIC IS SIAPLED OR WIRED DIRECTLY TO THE POSTS WITH ALL OTHER PROVISIONS OF ITEM (G) APPLYING.
- C. THE TRENCH SHALL BE BACKFILLED AND THE SOIL COMPACTED OVER THE FILTER FABRIC.
- SILT FENCES SHALL BE REMOVED WHEN THEY HAVE SERVED THEIR USEFUL PURPOSE BUT NOT BEFORE THE UPSLOPE AREAS HAVE BEEN PERMANENTLY STABLIZED.
- 2. SEQUENCE OF INSTALLATION


SEDIMENT BARRIERS SHALL BE INSTALLED PRIOR TO ANY SOIL DISTURBANCE OF THE CONTRIBUTINGDRAINAGE UPSLOPE OF THEM.

3. MAINTENANCE


- FERTILIZER LIME AND FERTILIZER SHOULD BE APPLIED EVENLY OVER THE AREA PROR TO OR
 AT THE TWE OF SECTION AND INCORPORATED INTO THE SOIL. KINDS AND
 AMOUNTS OF LIME AND FERTILIZER SHOULD BE BASED ON AN EVALUATION OF SOIL TESTS. WHEN
 A SOIL TEST IS NOT AVAILABLE, THE FOLLOWING MINIMUM AMOUNTS SHOULD BE APPLIED.
 ACRICULTURAL LIMESTOR © 100 LBS. PER 1,000 S.F. 10-20-20 FERTILIZER @ 12 LBS. PER
 1,000 S.F. SEED MIXTURE (RECOMMENDED):
- GRASS SEED: PROVIDE FRESH, CLEAN, NEW-CROP SEED COMPLYING WITH TOLERANCE FOR PURITY AND GERMINATION ESTABLISHED BY OFFICIAL SEED ANALYSTS OF MORTH MARIEGOA. PROVIDE SEED MIXTURE COMPOSED OF GRASS SPECIES, PROPORTIONS AND MINIMUM PERCENTAGES OF PURITY AS SPECIFIED.

Nome	Proportion by Weight	% Germination
Baron Bluegrass	20%	80
Kentucky Bluegrass	20%	80
Creeping Red Fescue	35%	85
Champion Perennial Ryegrass	25%	90


4. SODDING – SODDING IS DONE WHERE IT IS DESIRABLE TO RAPIDLY ESTABLISH COVER ON A DISTURBED AREA. SODDING AN AREA MAY BE SUBSTITUTED FOR PERMANENT SEEDING PROCEDURES ANYWHERE ON SITE. BED PREPARATION, FERTILIZING, AND PLACEMENT OF SOD SHALL BE PERFORMED ACCORDING TO THE S.C.S. HANDBOOK, SODDING IS RECOMMENDED FOR SITEP SLOPED AREAS, AREAS IMMEDIATELY ADJACENT TO A SENSITIVE WATER COURSE, EASILY ERODBLEL SOILS (TRILL SAND/SILT) LTC.

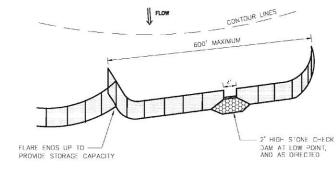

SILT FENCE LAYOUT

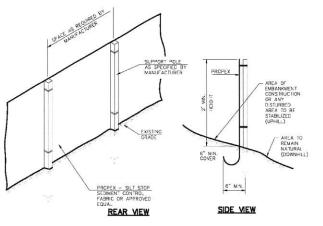

SILT FENCE DETAIL NOT TO SCALE

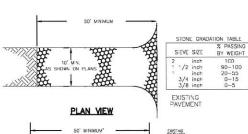

CONSTRUCTION SPECIFICATIONS


EXISTING


- STONE SIZE NHDOT STANDARD STONE SIZE #4 SECTION 703 OF NHDOT STANDARD SPECIFICATIONS. (SEE GRADATION TABLE)
- 2. LENGTH DETAILED ON PLANS (50 FOOT MINIMUM).

PROFILE

- 3. THICKNESS SIX (6) INCHES (MINIMUM).
- 4. WIDTH FULL DRIVE WIDTH (10 FOOT MINIMUM).
- 5. FILTER FABRIC MIRAFI 500X OR APPROVED EQUAL.
- SURFACE WATER CONTROL ALL SURFACE WATER THAT IS FLOWING TO OR DWERTED TOWARD THE CONSTRUCTION ENTRANCE SHALL BE PIPED BENEATH THE ENTRANCE. IF PIPING IS IMPRACTICAL, A BERM WITH 5.1 SLOPES THAT CAN BE CROSSED BY VEHICLES MAY BE SUBSTITUTED FOR THE PIPE.
- MANTENANCE THE ENTRANCE SHALL BE MAINTAINED IN A CONDITION WHICHWILL PREVENT TRACKING OR FLOWING OF SEDIMENT ONTO PUBLIC RIGHTS—OF-WAY, THIS WILL REQUIRE PERCODIC TOP DRESSING WITH ADDITIONAL SIDE OF ADDITIONAL SIDE OF ADDITIONAL SIDE OF ADDITIONAL SIDE OF A SIDE OF
- WHEELS SHALL BE CLEANED TO REMOVE MUD PRIOR TO ENTRANCE ONTO PUBLIC RIGHTS-OF-WAY. WHEN WASHING IS REQUIRED, IT SHALL BE DONE ON AN AREA STABLIZED WITH STONE WHICH DRAINS INTO AN APPROVED SEDIMENT TRAPPING DEVICE.

STABILIZED CONSTRUCTION ENTRANCE

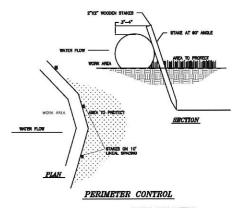

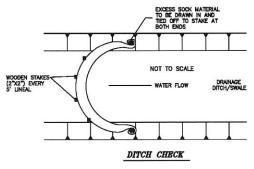

NOTE: FOLLOW MANUFACTURER'S SPECIFICATION and Design Normal, Version 5.0, 2006 SILT SOCK DETAIL NOT TO SCALE



265 WADLEIGH FALLS ROAD LEE, NEW HAMPSHIRE 03861 PH: 603-292-5787 WWW.FARWELLENGINEERING.COM




ISSUED FOR: ISSUE DATE:

FILE NAME:

APPROVAL

MARCH 6, 2020

1958-BARRINGTON SHORES

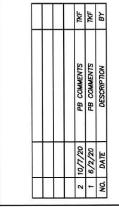

SCALE:

1" = 30'

OWNER/APPLICANT:


BARRINTON SHORES, 240 REVERE STREET WINTHROP. MA 02152

TAX MAP/LOT 121/28 7 BARRINGTON SHORE DRIVE BARRINGTON, NH


TITLE:

DETAILS

SHEET NUMBER:

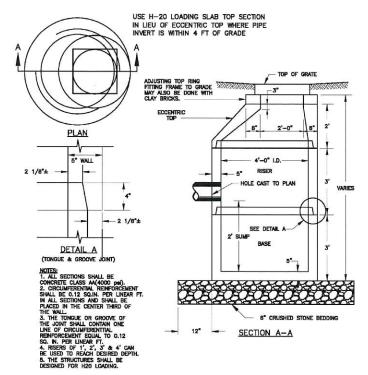


CATCH BASIN AND DRAIN MANHOLE

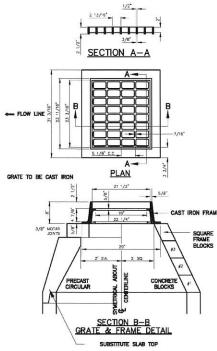

CATCH BASIN FRAME & GRATE



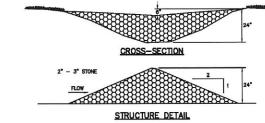



MAINTENANCE

CONSTRUCTION SPECIFICATIONS

- 1. STRUCTURES SHALL BE INSTALLED ACCORDING TO THE DIMENSIONS SHOWN ON THE PLANS AT THE APPROPRIATE SPACING
- PAINS AT THE APPRICIPANT SPACEDY

 C CONSTRUCTION SPERMINDS SHALL BE CARRED DUT IN SUCH A MANNER SO THAT

 STERMA, TERRITATION, AND WATER POLIUTION WILL BE WINNIEDD

 STERMA, TERRITATION, AND DULIDHONG SHALL CONFIDER TO THE RECOMMENDATIONS


 STERMA, TERRITATION, AND DULIDHONG SHALL CONFIDER TO THE RECOMMENDATIONS

 STERMA COMPLETED.

 STERMA COMPLETED.

STONE CHECK DAM DETAIL

NOT TO SCALE

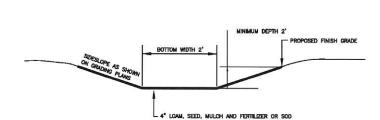


- THE FOUNDATION AREA OF THE WATERWAY SHALL BE CLEARED AND GRUBBED OF ALL TREES, BRUSH, STUMPS, AND OTHER OBJECTIONABLE MATERAL.
 MATERIALS REMOVED SHALL BE DISPOSED OF SO THEY WILL NOT INTERFERE WITH THE CONSTRUCTION OF PROPER FUNCTIONING OF THE WATERWAY.


- THE WATERWAY SHOULD BE INSPECTED PERIODICALLY AND AFTER EVERY MAJOR STORM TO DETERMINE THE CONDITION OF THE WATERWAY. RULIS AND DAMAGED AREAS SHOULD BE PROMPTLY REPAIRED AND REVENETIED AS NECESSARY TO PREVENT FURTHER DETERMINATION.
- 8. PERIODIC APPLICATIONS OF LIME AND FERTILIZER MAY BE NEEDED TO MAINTAIN VIGOROUS GROWTH.

GRASSED SWALE

NOT TO SCALE

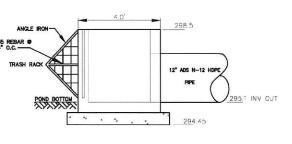



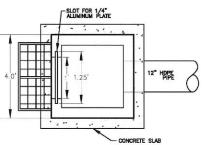

-ANGLE IRON TAR WITH 1/2" DIA BOLT

FRONT VIEW

#5 REBAR @ 8" O.C., TYP.

SLOT FOR 1/4" ORIFICE PLATE

TRASH RACK ANGLE AREA


4" DIAM. ORIFACE INV. 296.5

2" DIAM. ORIFACE INV. 295.11

TOP VIEW

POND STRUCTURE COVER

OUTLET STRUCTURE #1

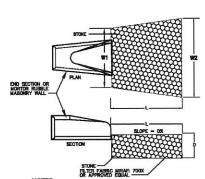

NOTES:

- 1. STONE SIZE AND MAT DIMENSIONS DETAILED ON SITE PLANS.
- 2. FIELD STONE, QUARRY STONE, OR ROCK FRAGMENTS SHALL BE SOUND, OF APPROVED QUALITY, AND FREE FROM STRUCTURAL DEFECTS. THE STONES SHALL BE ANOULAR AND APPROXIMATELY RECTANGULAR IN SHAPE. FLAT OR ROUND ROCKS ARE NOT ACCEPTABLE.
- 3. A WELL GRADED MIXTURE OF ROCK SIZES SHALL BE USED FOR STONE. FIFTY PERCENT BY WEIGHT OF THE STONE MIXTURE SHALL BE SMALLER THAN THE MEDIAN SIZE STONE (450). THE LARGEST STONE SIZE IN THE MIXTURE SHALL BE 1.5 TIMES THE 450 SIZE.

RIP RAP OUTLET PROTECTION NOT TO SCALE

ENGINEERING SERVICES, LLC

265 WADLEIGH FALLS ROAD LEE, NEW HAMPSHIRE 03861 PH: 603-292-5787 WWW.FARWELLENGINEERING.COM




ISSUED FOR:

APPROVAL

ISSUE DATE: MARCH 6, 2020

FILE NAME:

1958-BARRINGTON SHORES

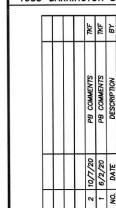

SCALE:

1" = 30'

OWNER/APPLICANT:


BARRINTON SHORES, LLC 240 REVERE STREET WINTHROP, MA 02152

TAX MAP/LOT 121/28 7 BARRINGTON SHORE DRIVE BARRINGTON, NH

TITLE:

DETAILS

SHEET NUMBER:

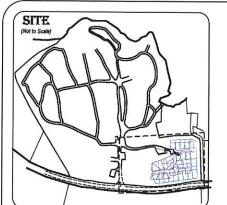

B1	16" Pine	B26	20" Pine	B49	12" Oak
B2	9" Pine	B27	25", 25" & 2" Maple	B50	1" Beec
B3	9ª Pine	B27b	2" Maple	B51	4" Cher
B4	2", 11/4 & 1" hardwood	B28	Beech sapling	B52	1" Beec
B5	B* Oak	B29	Maple Sapling	B53	3" Beec
B6	9" Maple	B30	3", 3", 3", 4" & 6" Maple	B54	2" Beec
B7	15" Pine	B31	Beech sapling	B55	2" Beec
B8	11/4 & 11/4" hardwood	B32	1" Beech	B56	9" Mapl
B9	hardwood shrub	B33	hardwood clump	B57	9" Oak
B10	2½" hardwood	B34	2" Beech	B58	2" Oak
B11	hardwood shrub	B35	2" Beech	B59	2" Mapi
B12	triple hardwood saplings	B38	17" Pine	B60	6" Beec
B13	11/3" Beech	B38b	7" Pine	B61	17" Pine
B14	sapling cluster	B37	2" Beech	B62	8" Pine
B15	2", 2" & 3" Beech	B38	1" Birch	B63	3" Chen
B16	sapling	B39	3" Birch	B64	2" Chen
B17	10" Oak	B40	4" Maple	B65	6" Beec
B18	11/3" Beech	B41	2" Cherry	B66	1% 82
B19	6" Ash	B42	9" Oak	B67	15" Pine
B20	sapling	B43	6", 6", 12" & 12" Oak	B68	2" Chen
B21	9" Ash	B44	1" Maple	B69	6" Pine
B22	sapling cluster	B45	10" Oak	B70	3" Chen
B23	4" Cherry	B46	3° & 3° Birch	*#8 i	n Arborist
D24	bandon of stance		44 MI 1		

EXISTING BUFFER TREE LEGEND:

EXISTING TREE IDENTIFIER

EXISTING EVERGREEN TREE EXISTING DECIDUOUS TREE



EXISTING SHRUB / SAPLING

EXISTING TREE TO BE REMOVED

PROPOSED BUFFER TREE LEGEND:



PROPOSED 1-2" CALIPER TREE - SHADE TOLERENT

PROPOSED - EVERGREEN SAPLING - SHADE TOLERENT

PROPOSED - SHRUBS

PROPOSED BUFFER TREES:

Areas with more sunlight

Viburnums Spiceberry Red Keple Black Birch Chakecherry Winterberry - Moster gites

OCT 13 2020

 THE SAMPLE VEGETATION SECTION IS A 90 FOOT SETCTION OF THE PROPOSED BUFFER SHOWING THE EXISTING VEGETATION AROUND THE PROPERTY. THIS IS TYPICAL OF THE VEGETATION AROUND THE ENTIRE BUFFER. LAND USE OFFICE

2. THE BUFFER AREA IS TO BE ENHANCED PER RECOMMENDATIONS FROM THE UNIVERSITY OF NEW HAMPSHIRE COOPERATIVE EXTENSION SERVICE. SEE LETTER FROM ANDY FAST, STRAFFORD COUNTY FORESTER DATED MARCH 19, 2019.

LOCUS

3. TREE CLEARING WILL BE PERFORMED UNDER THE RECOMMENDATIONS FROM UNBAN TREE SERVICE. SEE LETTER FROM EDWARD ROY, CERTIFIED ARBORIST AND TREE RISK ASSESSMENT QUALIFIED ARBORIST DATED JULY 19, 2019.

VEGETATED BUFFER NOTES:

1. THE ENHANCED VEGETATIVE BUFFER AREA IS FIFTY FEET WIDE AND BEGINS AT SITE #1 AND ENDS AT SITE #19 AS SHOWN ON THE BUFFER ENHANCEMENT AREA.

2. THE INTENT OF THIS PLAN IS TO PROVIDE GUIDANCE FOR PROVIDING A VISUAL BARRIER TO THE CAMPGROUND. THIS IS A MATURE FOREST AREA THAT HAS LIMITED BOTTOM BRANCHES WHICH CREATES A VISUALLY OPEN OXODS. BY INTRODUCING NEW SHADE TO LERANT EVERGREEN AND DECIDIOUS TREES AND SHRUBS THIS WILL PROVIDE A DENSER VISUAL BARRIER. THE ABUTTERS HAVE REQUESTED THAT


3. WITHIN 30 DAYS OF THE TREE REMOVAL FOR THIS PROJECT, THE OWNER SHALL PROVIDE A MIX OF 1-2° CALIPER EVERGREEN TREES (5° -8° IN HEIGHT) FROM THE LIST NOTED BELOWAS WELL AS SEEDLINGS FROM THE SITE FOREST NINESHORD SHALL ALSO BE USED IN THE BUFFER AREA ADJACENT TO HALL ROAD, GIVEN THE MORTALITY RATE OF THE SEEDLINGS, IT IS RECOMMENDED THAT THERE BE 5 SEEDLINGS FOR EACH 1-2° CALIPER EVERGREEN. SHRUBS SHALL BE PLACED AS NECESSARY TO ROUND OUT THE VISUAL BUFFER.

4. ALONG THE BUFFER AREA EXCLUDING LOCATIONS AS INDICATED IN NOTE #3, LARGER THAN 12 FEET IN DIAMETER VIOLO SHALL BE IDENTIFIED AND THREE EVERGREEN SAPLINGS SHALL BE PLANTED. SHRUBS SHALL BE PLACED AS NECESSARY TO ROUND OUT THE VISUAL BUFFER THIS IS INTENDED TO AID IN VISUAL

5. THIS BUFFER SHALL BE MAINTAINED YEARLY. THE BUFFER SHALL BE WALKED AND ADDITIONAL SEEDLINGS AND SHRUBS SHALL BE ADDED TO THE BUFFER AREA.

6. IF THERE IS A DISPUTE OVER THE BUFFER, THE TOWN CODE EMPORCEMENT OFFICER SHALL INSPECT THE BUFFER AND MAKE A DETERMINATION OF ADDITIONAL PLANTING.

7. ROUGH BOARD FENCE TO BE 6 FEET MINIMUM IN HEIGHT AND TO BE INSTALLED MEANDERING AROUND EXISTING TREES. INTERNITTENT FENDING WILL BE INSTALLED ALONG HALL ROAD WITH EVERGREENS BETWEEN OPENINGS. SEE NOTE #3 ABOVE.

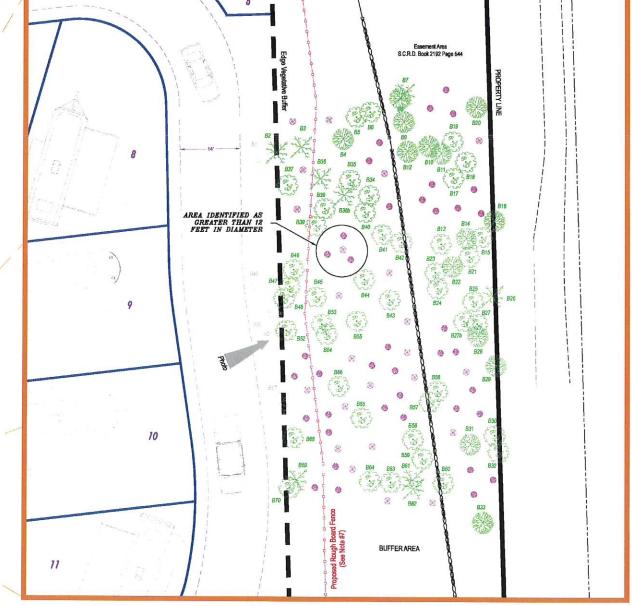

TYPICAL VEGETATION ENHANCEMENT SECTION

REV	DATE	STATUS	

LANDSCAPE PLAN

of a Portion of Property Located at: 7 Barrington Shores Drive Barrington, NH 03825

Barrington Shores, LLC 240 Revere Street Winthrop, MA 02152



265 WADLEIGH FALLS ROAD LEE, NEW HAMPSHIRE 03824 PH: 603-292-5787 WWW.FARWELLENGINEERING.COM




Licensed in New Hampshire & Maine PO Box 458, Barrington, NH 03825 t: (603) 664-3900 www.StonewallSurveying.com

121 / 28		18038 Layout - June 2020.dwg		
SCALE:	SHEET:	PROJECT NO:	DATE:	
AS NOTED	1 of 1	18036	Oct 13, 2020	



SAMPLE PHOTOS

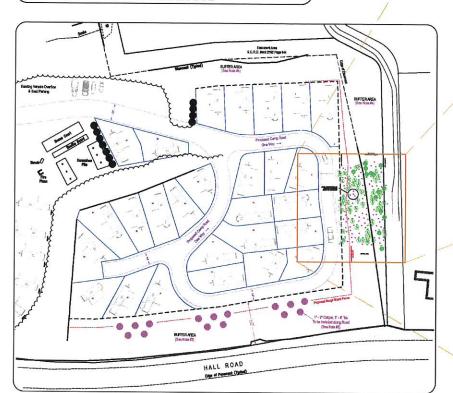

OVERALL BUFFER ENHANCEMENT AREA